MONTPELIER PUBLIC HIGH SCHOOL

2014 MAIN PARKING LOT IMPROVEMENTS



DRAWING INDEX

TITLE SHEET

C1-00 LEGEND & NOTES

C1-01 EXISTING CONDITIONS & DEMOLITION PLAN

C2-01 SITE PLAN

C2-02 SITE PLAN

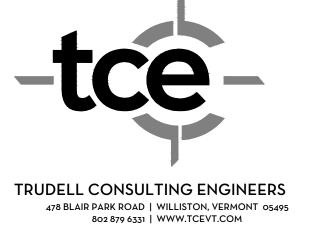
C8-01 SITE DETAILS

C8-02 SITE DETAILS

OWNER:

MONTPELIER PUBLIC SCHOOLS
5 HIGH SCHOOL DRIVE
MONTPELIER, VERMONT 05602
(802) 225-8000

Civil Engineer:
TRUDELL CONSULTING ENGINEERS (TCE)
478 BLAIR PARK ROAD
WILLISTON, VT 05495
(802) 879-6331



USE AND INTERPRETATION OF THE DRAWINGS

Unless otherwise noted, these Drawings are intended for preliminary planning, coordination with other disciplines or utilities, and/or approval from the regulatory authorities. They are not intended as construction drawings unless noted as such.

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BEFORE USING THESE PLANS ENSURE THAT YOU HAVE THE LATEST REVISION

TCE PROJECT NO: 13-056

REVISION HISTORY:

1 - BID SET SUBMISSION 2 - ADDENDUM No. 1 06/12/2014 06/25/2014

LEGEND

		LINE				SYMBOL	
CITE	EXISTING	PROPOSED	REMOVED/ABANDONED		EXISTING	PROPOSED	REMOVED/ABANDONEI
SITE				SITE			
PAVED DRIVE OR ROAD				SIGN	þ	•	셤
GRAVEL DRIVE OR ROAD							
PAVED DRIVE OR ROAD WITH CURB				UTILITIES			
TREE LINE		~~~~~		SEWER MANHOLE (SMH)	0	•	0
TRAIL			viiiiiiiiiiiiiiiiiiiiiiiiiiiiiiiiiiiii	SEWER CLEANOUT (CO)	0	•	o
WETLAND LIMIT				PUMP STATION (PS)	®	©	(S)
TOPOGRAPHIC CONTOURS		124 —		STORM DRAINAGE MANHOLE (DMH)	0	•	0
STREAM	->>-	->>-	>	CATCH BASIN (CB)			
SILT FENCE				STORM DRAINAGE CLEANOUT	0	•	0
<u>UTILITIES</u>				OUTLET OR END SECTION	<	<	<
SEWER MAINS AND SERVICES	s	s	s s	VALVE	M	×	: ×\$
SEWER FORCEMAIN	FM		FM FM FM	CURB STOP (CS)	⊗	•	⊗
WATER MAINS AND SERVICES	w	w	w w w	FIRE HYDRANT (HYD)	¢ı	À	٠ ا
STORM DRAINAGE	D	D	D D D	WATER SUPPLY WELL	· Ø	· •	· · · · · · · · · · · · · · · · · · ·
CURTAIN DRAIN	CD	CD	CD CD CD	END CAP	[[Ε
UNDERDRAIN	UD	UD	UD UD UD	BLOWOFF	8	•	- ô
ROOF DRAIN		RD	RD RD RD	UTILITY POLE	-0-	-⊕-	-0-
FOOTING DRAIN	———— FD ————	FD	FD FD FD	MTC OR		_	
LIQUID PROPANE		G	G G G	TRANSFORMER TELEPHONE MANHOLE	0	_	0
OR NATURAL GAS OVERHEAD POWER	OHP	OHP	OHP OHP OHP	TELEPHONE PEDESTAL			П
UNDERGROUND POWER			IIP IIP IIP	LUMINAIRE	>□	-	•©
OVERHEAD TELEPHONE	OHT	OHT	—— ОНТ——— ОНТ——— ОНТ———	BOLLARD LIGHT	↓	 -	÷.
UNDERGROUND	UII	——————————————————————————————————————	UT UT UT	TELEVISION PEDESTAL	0	•	Υ Ο
TELEPHONE OVERHEAD POWER &	— UI — — —	- UI -		FIELD	O	•	O
TELEPHONE UNDERGROUND POWER &	— — OHr&I — — —	——— OHP&I			٨		
TELEPHONE OVERHEAD POWER,	UP&I	UP&I		CALCULATED POINT TCE CONTROL POINT	Δ		
TELEPHONE & CABLE UNDERGROUND POWER,	— — OHP&T&C — — —	OHP&T&C	OHP&T&C OHP&T&C	STEEL REBAR TCE CONTROL POINT	•		
TELEPHONE & CABLE	—— —— UP&T&C —— ——		——————————————————————————————————————	MAG NAIL	•		
CABLE TELEVISION	CTV	CTV	CTV CTV CTV	OBSERVATION WELL	A		
FIBER OPTIC	—— — FO —— ——	FO	FO FO FO	PERCOLATION TEST	•		
SURVEY				SOIL TEST PIT	-		
PROPERTY LINE				SOIL BORING	•		
RIGHT-OF-WAY LINE				BENCHMARK	•		
EASEMENTS				<u>SURVEY</u>	FOUND	TO BE SET	SET
FENCE	$\overline{}$		Χ				
STONEWALL				IRON PIPE	•		
BUILDING SETBACKS				STEEL REBAR	•	0	Ø
				CONCRETE MONUMENT	•		Ø
LEGEND NOTE:				MARBLE OR STONE MONUMENT			
	BE PROVIDED BY OTHERS AND COULD BE SHOW	'n with a different symbol not shown c	N THIS LEGEND. HOWEVER, THEY	IRON PIN (IP)	•		

ARE LABELED ON RESPECTIVE PLANS. IN SOME CASES A CHANGE IN SCALE OR PRINTER CAN ALTER INFORMATION TO NOT SHOW AN EXACT MATCH ON THIS LEGEND. IF ANY QUESTIONS EXIST CONTACT THE ENGINEER TO CLARIFY, ADDITIONAL LEGEND INFORMATION IS SUPPLIED SEPARATELY ON EROSION CONTROL PLANS AND SOME SURVEY PLATS.

SURVEY NOTES:

- 1. THE PURPOSE OF THE EXISTING CONDITIONS PLAN IS TO DEPICT PERTINENT EXISTING CONDITIONS AS OF THE DATE OF SURVEY JULY 2013.
- 2. BEARINGS SHOWN ARE BASED UPON VERMONT GRID NORTH.
- 3. VERTICAL DATUM IS BASED ON NAVD88 (GEOID 12).
- 4. COORDINATE SYSTEM IS BASED ON VERMONT STATE PLANE (U.S. SURVEY FEET).
- 5. HORIZONTAL AND VERTICAL CONTROL ESTABLISHED WITH RTK GPS OBSERVATIONS FROM THE VCAP CORS STATION. A TRIMBLE R6 RTK GPS UNIT WAS EMPLOYED FOR THESE
- 6. THE LOCATION OF EXISTING UNDERGROUND UTILITIES AND IMPROVEMENTS SHOWN ARE BASED ON RESEARCH, UTILITY PLANS PROVIDED BY OTHERS, AND/OR SURFACE EVIDENCE ENCOUNTERED AND WERE OBTAINED IN A MANNER CONSISTENT WITH THE ORDINARY STANDARD OF PROFESSIONAL CARE AND HAVE NOT BEEN INDEPENDENTLY VERIFIED BY THE OWNER OR THE DESIGN ENGINEER. ADDITIONAL UTILITIES NOT SHOWN MAY EXIST. ENGINEER SHALL BE NOTIFIED IF ANY DISCREPANCIES ARE ENCOUNTERED. ACTUAL LOCATION OF UNDERGROUND UTILITIES MAY VARY. DIGSAFE MUST BE CONTACTED PRIOR TO ANY EXCAVATION.

PICTURES OF VARIOUS AREAS DEEMED NECESSARY BY THE ENGINEER OR OWNER.

7. THIS PLAN DOES NOT DEPICT A FORMAL BOUNDARY SURVEY.

RECORD DRAWING REQUIREMENTS:

- A CLEAN SET OF UP TO DATE RECORD DRAWINGS IS TO BE AVAILABLE FOR REVIEW ON SITE AT ALL TIMES. FOR JOBS LASTING MORE THAN 4 WEEKS A REVIEW OF THE RECORD DRAWINGS WILL BE DONE BY THE ENGINEER EVERY 2 WEEKS AND COMMENTS OR DEFICIENCIES MAY BE PROVIDED.
- 2) TIES TO ALL BENDS, VALVES, JOINTS, CONNECTIONS AND DESIGN FEATURES SHALL BE PROVIDED. TIES SHALL BE PULLED FROM EASILY LOCATABLE PERMANENT ABOVE GROUND FEATURES THAT ARE VISIBLE YEAR AROUND SUCH AS BUILDING CORNERS, HYDRANTS, SEWER AND STORM DRAIN COVERS THAT WILL BE CLEARED IN WINTER, UTILITY POLES, ETC. REFRAIN FROM PROVIDING TIES WITH ACUTE ANGLES. TIES SHOULD BE PULLED AT ANGLES AS CLOSE TO 90 DEGREES AS POSSIBLE. TIES WITH ANGLE TOO ACUTE
- 3) RECORD INFORMATION NEEDS TO BE PROVIDED ON THE APPROPRIATE DESIGN PLANS ON A WEEKLY BASIS. RECORD INFORMATION REGARDING TCE DESIGN ITEMS PLACED ON INAPPROPRIATE DESIGN PLANS WILL NOT BE ACCEPTED.
- 4) IF ENGINEERING SERVICES FOR BI-WEEKLY REVIEW OF RECORD INFORMATION HAVE NOT BEEN OBTAINED FOR THE PROJECT ALL RECORD INFORMATION FOR TCE DESIGN ITEMS SHALL BE PROVIDED TO TCE WITHIN 7 BUSINESS DAYS OF THE COMPLETION OF THE WORK.
- 5) PLANS SUBMITTED AT THE END OF THE PROJECT SHALL BE REVIEWED FOR COMPLETENESS. ALL REQUIREMENTS LISTED ABOVE APPLY.
- 6) IF DESIGN FEATURES WERE INSTALLED EXACTLY PER THE DESIGN PLANS TIES TO THE FEATURE ARE STILL REQUIRED TO BE PROVIDED BY THE CONTRACTOR FOR THE OWNERS USE. ANY FEATURE NOT INDICATED AS DIFFERENT IN RED WILL BE CONSIDERED TO BE EXACTLY PER DESIGN.
- 7) RECORD INFORMATION SHALL INCLUDE BOTH VERTICAL AND HORIZONTAL LOCATIONS, THIS INCLUDES BUT IS NOT LIMITED TO FINISHED FLOOR ELEVATIONS, RIMS AND INVERTS OF STRUCTURES AND PIPING, INVERTS AT CROSSINGS, ETC
- 8) ANY UTILITIES ENCOUNTERED THAT ARE NOT SHOWN ON THE PLANS SHALL BE ADDED TO THE PLANS WITH APPROPRIATE TIES.
- 9) TIES SHALL INCLUDE ALL UTILITIES INSTALLED BY CONTRACTOR WHICH INCLUDE BUT ARE NOT LIMITED TO SEWER, WATER, STORM, ELECTRIC, CABLE, TELEPHONE, GAS, ETC.
- 10) RECORD DRAWINGS SHALL BE SUPPLIED ON BOTH HARD COPY AND ELECTRONIC DATA. ELECTRONIC DATA SHALL BE COMPUTER-AIDED DESIGN (CAD) FILES INCLUDING NATIVE FILE FORMATS (DWG).
- 11) THE CONTRACTOR SHALL SUBMIT ON A WEEKLY BASIS PROJECT PHOTOGRAPHS. THE INFORMATION WILL BE SUBMITTED TO THE ENGINEER IN ELECTRONIC FORMAT WITH EACH PICTURE BEING LABELED BY DATE, LOCATION AND ACTIVITY. AT A MINIMUM THE CONTRACTOR WILL SUBMIT PICTURES OF ALL THRUST BLOCKS, CONNECTIONS TO EXISTING FACILITIES AND STRUCTURES BEFORE AND AFTER BACKFILL. PROVIDE AUXILIARY LIGHTING AS REQUIRED TO PRODUCE CLEAR, WELL-LIT PHOTOGRAPHS WITHOUT OBSCURING SHADOWS. THE CONTRACTOR SHALL MAINTAIN ONE CHECK SET OF PHOTOGRAPHS AT THE SITE FOR REFERENCE. UPON REQUEST THE CONTRACTOR SHALL PROVIDE
- 12) CERTIFICATIONS BY THE ENGINEER AND SUCCESSFUL TEST RESULTS DO NOT RELIEVE THE CONTRACTOR OF FULL COMPLIANCE WITH THE DESIGN PLANS, SPECIFICATIONS AND PERMITS SHOULD A DEFICIENCY BE DISCOVERED AFTER SAID CERTIFICATION OR TESTING.

- CONSTRUCTION NOTES: CONTRACT DOCUMENTS:THESE PLANS WERE PREPARED BY TRUDELL CONSULTING ENGINEERS (TCE) AND ARE INTENDED TO BE USED IN CONJUNCTION WITH THE STANDARD GENERAL CONDITIONS OF THE CONSTRUCTION CONTRACT, #C-700 PREPARED BY THE ENGINEERS JOINT CONTRACT DOCUMENTS COMMITTEE (EJCDC), LATEST EDITION. COPIES ARE AVAILABLE
- 2. UNDERGROUND IMPROVEMENTS: THE LOCATION OF EXISTING UNDERGROUND UTILITIES AND IMPROVEMENTS SHOWN ARE ASSUMED BASED ON RESEARCH, UTILITY PLANS PROVIDED BY OTHERS, AND/OR SURFACE EVIDENCE AVAILABLE AND WERE OBTAINED IN A MANNER CONSISTENT WITH THE ORDINARY STANDARD OF PROFESSIONAL CARE AND HAVE NOT BEEN INDEPENDENTLY VERIFIED BY THE OWNER OR THE DESIGN ENGINEER.
- 3. DIFFERING SUBSURFACE OR PHYSICAL CONDITIONS: IF CONTRACTOR BELIEVES THAT ANY SUBSURFACE OR PHYSICAL CONDITION AT OR CONTIGUOUS TO THE SITE THAT IS UNCOVERED OR REVEALED EITHER: (1) IS OF SUCH A NATURE AS TO ESTABLISH THAT ANY "TECHNICAL DATA" ON WHICH CONTRACTOR RELIED IS MATERIALLY INACCURATE; OR (2) IS OF SUCH A NATURE AS TO REQUIRE A CHANGE IN THE PLANS/ CONTRACT DOCUMENTS; OR (3) DIFFERS MATERIALLY FROM THAT SHOWN OR INDICATED IN THE PLANS/CONTRACT DOCUMENTS; OR (4) IS OF AN UNUSUAL NATURE, AND DIFFERS MATERIALLY FROM CONDITIONS ORDINARILY ENCOUNTERED AND GENERALLY RECOGNIZED AS INHERENT IN WORK OF THE CHARACTER PROVIDED FOR IN THE PLANS/CONTRACT DOCUMENTS; THEN CONTRACTOR SHALL, PROMPTLY AFTER BECOMING AWARE THEREOF AND BEFORE FURTHER DISTURBING THE SUBSURFACE OR PHYSICAL CONDITIONS OR PERFORMING ANY WORK IN CONNECTION THEREWITH (EXCEPT IN AN EMERGENCY), NOTIFY OWNER AND ENGINEER ABOUT SUCH CONDITION. CONTRACTOR SHALL NOT FURTHER DISTURB SUCH CONDITION OR PERFORM ANY WORK IN CONNECTION THEREWITH (EXCEPT AS AFORESAID) UNTIL RECEIPT OF WRITTEN ORDER TO DO
- 4. UTILITIES: PRIVATE AND PUBLIC UTILITIES SUCH AS ELECTRIC, TELEPHONE, GAS, CABLE, FIBER OPTIC ETC. ARE THE RESPONSIBILITY OF THE RESPECTIVE UTILITY COMPANY. ANY INFORMATION SHOWN BY TCE SHOULD BE CONSIDERED PRELIMINARY (USUALLY TO ASSIST WITH PERMITTING). FINAL DESIGN, CONSTRUCTION AND MAINTENANCE ARE THE RESPONSIBILITY OF RESPECTIVE UTILITY COMPANIES, COMPLIANCE WITH EASEMENTS AND REGULATIONS (STATE AND LOCAL) ARE THE RESPONSIBILITY OF RESPECTIVE UTILITY COMPANY.
- 5. DIGSAFE: IN ACCORDANCE WITH VERMONT STATE LAW (VSA TITLE 30 CHAPTER 86 AND PSB RULE 3,800) THE CONTRACTOR SHALL BE RESPONSIBLE TO CONTACT DIGSAFE SYSTEMS, INC. "DIGSAFE". AT LEAST 48 HOURS , EXCLUDING SATURDAYS, SUNDAYS, AND LEGAL HOLIDAYS, BUT NOT MORE THAN 30 DAYS BEFORE COMMENCING EXCAVATION ACTIVITIES, EXCEPT IN AN EMERGENCY. THE CONTRACTOR SHALL BE RESPONSIBLE FOR PRE-MARKING THE SITE AND MAINTAINING DESIGNATED MARKINGS. FOR MORE INFORMATION ON DIGSAFE REQUIREMENTS SEE <u>WWW.DIGSAFE.COM</u>
- 6. JOBSITE SAFETY: NEITHER THE PROFESSIONAL ACTIVITIES OF TRUDELL CONSULTING ENGINEERS (TCE), NOR THE PRESENCE OF TCE OR ITS EMPLOYEES AND SUB CONSULTANTS AT A CONSTRUCTION SITE, SHALL RELIEVE THE GENERAL CONTRACTOR AND ANY OTHER ENTITY OF THEIR OBLIGATIONS, DUTIES AND RESPONSIBILITIES INCLUDING, BUT NOT LIMITED TO, CONSTRUCTION MEANS, METHODS, SEQUENCE, TECHNIQUES OR PROCEDURES NECESSARY FOR PERFORMING, SUPERINTENDING OR COORDINATING ALL PORTIONS OF THE WORK OF CONSTRUCTION IN ACCORDANCE WITH THE CONTRACT DOCUMENTS AND ANY HEALTH OR SAFETY PRECAUTIONS REQUIRED BY ANY REGULATORY AGENCIES. TCE AND ITS PERSONNEL have no authority to exercise any control over any construction contractor or other entity or their employees in connection with their work or any health OR SAFETY PRECAUTIONS. THE CLIENT AGREES THAT THE GENERAL CONTRACTOR IS SOLELY RESPONSIBLE FOR JOBSITE SAFETY, AND WARRANTS THAT THIS INTENT SHALL BE MADE EVIDENT IN THE CLIENT'S AGREEMENT WITH THE GENERAL CONTRACTOR. THE CLIENT ALSO AGREES THAT THE CLIENT, TCE AND TCE'S CONSULTANTS SHALL BE INDEMNIFIED AND SHALL BE MADE ADDITIONAL INSURED UNDER THE GENERAL CONTRACTOR'S GENERAL LIABILITY INSURANCE POLICY.
- 7. CODES AND STANDARDS COMPLIANCE:TCE SHALL EXERCISE USUAL AND CUSTOMARY PROFESSIONAL CARE IN ITS EFFORTS TO COMPLY WITH CODES, STANDARDS, REGULATIONS, AND ORDINANCES IN EFFECT. THE OWNER ACKNOWLEDGES THAT SUCH REQUIREMENTS MAY BE SUBJECT TO VARIOUS AND CONTRADICTORY INTERPRETATIONS. TCE, THEREFORE, WILL USE ITS REASONABLE PROFESSIONAL EFFORTS AND JUDGMENT TO INTERPRET APPLICABLE REQUIREMENTS AS THEY APPLY TO THE PROJECT. TCE, HOWEVER, CANNOT AND DOES NOT WARRANT OR GUARANTEE THAT THE PROJECT WILL COMPLY WITH ALL INTERPRETATIONS OF SUCH REQUIREMENTS.
- 8. CONSTRUCTION OBSERVATION: TCE MAY VISIT THE PROJECT AT APPROPRIATE INTERVALS DURING CONSTRUCTION TO BECOME GENERALLY FAMILIAR WITH THE PROGRESS AND QUALITY OF THE CONTRACTOR'S WORK AND TO DETERMINE IF THE WORK IS PRECEDING IN GENERAL ACCORDANCE WITH THE CONTRACT DOCUMENTS. THE OWNER HAS NOT RETAINED TCE TO MAKE DETAILED INSPECTIONS OR TO PROVIDE EXHAUSTIVE OR CONTINUOUS PROJECT REVIEW AND OBSERVATION SERVICES. TCE DOES NOT GUARANTEE THE PERFORMANCE OF, AND SHALL NOT HAVE RESPONSIBILITY FOR, THE ACTS OR OMISSIONS OF ANY CONTRACTOR, SUB-CONTRACTOR, SUPPLIER OR ANY OTHER ENTITY FURNISHING MATERIALS OR PERFORMING ANY WORK ON THE PROJECT. TCE SHALL NOT SUPERVISE, DIRECT OR HAVE CONTROL OVER THE CONTRACTOR'S WORK NOR HAVE ANY RESPONSIBILITY FOR THE CONSTRUCTION MEANS, METHODS, TECHNIQUES, SEQUENCES OR PROCEDURES OF THE CONTRACTOR. IF THE OWNER DESIRES MORE EXTENSIVE PROJECT OBSERVATION OR FULL-TIME PROJECT REPRESENTATION, THE OWNER SHALL REQUEST SUCH SERVICES BE PROVIDED BY TCE AS ADDITIONAL SERVICES.
- 9. UTILITIES SHOWN ARE APPROXIMATE AND DO NOT NECESSARILY REPRESENT ALL UTILITIES LOCATED ON OR ADJACENT TO THE AREA SURVEYED. THE CONTRACTOR SHALL FIELD VERIFY ALL UTILITY CONFLICTS. ALL DISCREPANCIES SHALL BE REPORTED TO THE ENGINEER.
- 10. ALL EXISTING UTILITIES NOT INCORPORATED INTO THE FINAL DESIGN ARE TO BE REMOVED OR ABANDONED AS INDICATED ON THE PLANS.
- 11. THE CONTRACTOR SHALL MAINTAIN AS-BUILT PLANS (WITH TIES) FOR ALL UNDERGROUND UTILITIES. THOSE PLANS SHALL BE SUBMITTED TO THE OWNER AT THE COMPLETION OF THE PROJECT.
- 12. THE CONTRACTOR SHALL REPAIR/RESTORE ALL DISTURBED AREAS (ON OR OFF THE SITE) AS A DIRECT OR INDIRECT RESULT OF THE CONSTRUCTION.
- 13. ALL GRASSED AREAS SHALL BE MAINTAINED UNTIL FULL VEGETATION IS ESTABLISHED.
- 14. MAINTAIN ALL TREES OUTSIDE OF CONSTRUCTION LIMITS.
- 15. THE CONTRACTOR SHALL BE RESPONSIBLE FOR ALL WORK NECESSARY FOR COMPLETE AND OPERABLE FACILITIES AND UTILITIES.
- 16. IN ADDITION TO THE REQUIREMENTS SET IN THESE PLANS AND SPECIFICATIONS, THE CONTRACTOR SHALL COMPLETE THE WORK IN ACCORDANCE WITH ALL PERMIT CONDITIONS, LOCAL
- 17. ANY DEWATERING NECESSARY FOR THE COMPLETION OF THE SITE WORK SHALL BE CONSIDERED AS PART OF THE CONTRACT AND SHALL BE THE CONTRACTOR'S RESPONSIBILITY.
- 18. IF THERE ARE ANY CONFLICTS OR INCONSISTENCIES WITH THE PLANS OR SPECIFICATIONS, THE CONTRACTOR SHALL CONTACT THE ENGINEER FOR VERIFICATION BEFORE WORK CONTINUES ON THE ITEM(S) IN QUESTION.

CONSTRUCTION PHASE:

LISTED BELOW IS A BRIEF SUMMARY OF CONSTRUCTION PHASE REQUIREMENTS. THIS LIST IS NOT INTENDED TO BE ALL-INCLUSIVE. CONSTRUCTION SPECIFICATIONS, PERMIT REQUIREMENTS AND SUBSEQUENT CONTRACTUAL AGREEMENTS FROM PARTIES INVOLVED SHALL PREVAIL.

PRE-CONSTRUCTION

- OWNER TO ESTABLISH SCOPE OF SERVICES WITH PROJECT ENGINEER(S) OWNER TO IDENTIFY WORK SCOPE AND SCHEDULE
- UPON OWNER REQUEST, ASSIST WITH CONTRACTOR BID AND SELECTION PROCESS
- MEETING BETWEEN OWNER, ENGINEER(S), CONTRACTOR(S), ARCHITECT(S), REGULATORY AUTHORITIES AND OTHER PERTINENT PARTIES TO REVIEW AND DISCUSS THE WORK
- PRE-CONSTRUCTION MEETING CONTRACTOR TO IDENTIFY SUBCONTRACTORS
- CONTRACTOR TO ESTABLISH SCHEDULE CONTRACTOR TO DESIGNATE RESPONSIBLE PERSONNEL
- CONFIRM PROCEDURE FOR RFI'S, CHANGE ORDERS, EXTRAS AND PAY REQUESTS
- CONTRACTOR TO SUBMIT SHOP DRAWINGS CONTRACTOR TO OUTLINE SAFETY, SECURITY, AND WORKING HOURS
- CONTRACTOR OR OWNER TO IDENTIFY TESTING COMPANY

CONSTRUCTION PHASE

- INITIAL CONTROL SUPPLIED BY OWNER AND CONTRACTOR RESPONSIBLE FOR LAYOUT
- OWNER TO PROVIDE PROJECT ENGINEER TO OBSERVE CONSTRUCTION PERIODICALLY, DURING CRITICAL PHASES AND TESTING. WEEKLY JOB MEETINGS DURING CONSTRUCTION
- OWNER TO PROVIDE PROJECT ENGINEER TO REVIEW AND DISCUSS PLANS, ANSWER QUESTIONS, RESPOND TO CHANGES AND OTHER BUSINESS COMMON TO CONSTRUCTION SERVICES. OBSERVE TESTING AND COLLECT RESULTS
- OWNER AND CONTRACTOR TO COMPLY WITH PERMITS

GENERAL NOTES:

Owner:

MONTPELIER PUBLIC SCHOOLS

MONTPELIER, VERMONT 05602

TRUDELL CONSULTING ENGINEERS (TCE)

HIGH SCHOOL MAIN

5 HIGH SCHOOL DRIVE

PHONE: (802) 225-8000

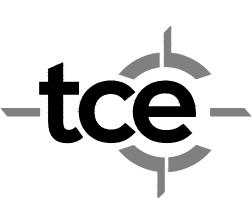
Civil Engineer:

478 BLAIR PARK ROAD

PHONE: (802)879-6331

WILLISTON, VT 05495

- 1. THE GENERAL CONTRACTOR IS REQUIRED TO CONFORM TO THE STRICTEST INTERPRETATION OF THE CONTRACT DRAWING, SPECIFICATION, PERMITS AND CONSTRUCTION CONTRACT. ALL EARTH MATERIAL RECEIVED OR DISPOSED FROM OUTSIDE SOURCES SHALL COMPLY WITH APPLICABLE PERMITS AND REGULATIONS. SHOP DRAWING SUBMITTALS SHALL INCLUDE CONTRACTOR'S CERTIFICATION STATEMENT OF COMPLIANCE AND COPIES OF RELEVANT PERMITS FOR OUTSIDE SOURCES.
- . CONTRACTOR SHALL PAY FOR ALL REQUIRED TESTING. THIS SHALL INCLUDE BUT IS NOT LIMITED TO: SOIL TESTING, COMPACTION TESTING, SIEVE ANALYSIS, CONCRETE TESTING, ASPHALT PENETRATION TESTING, BACTERIOLOGICAL TESTING FOR WATER AND OTHER TESTING AS PART OF STANDARD PRACTICE FOR A CONSTRUCTION PROJECT OF THIS NATURE, UNLESS INDICATED OTHERWISE AND APPROVED BY THE OWNER.



TRUDELL CONSULTING ENGINEERS 478 BLAIR PARK ROAD | WILLISTON, VERMONT 05495 802 879 6331 | WWW.TCEVT.COM

No. Description

∠1 Addendum No. 1 06/25/14 SMN

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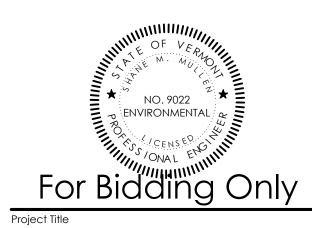
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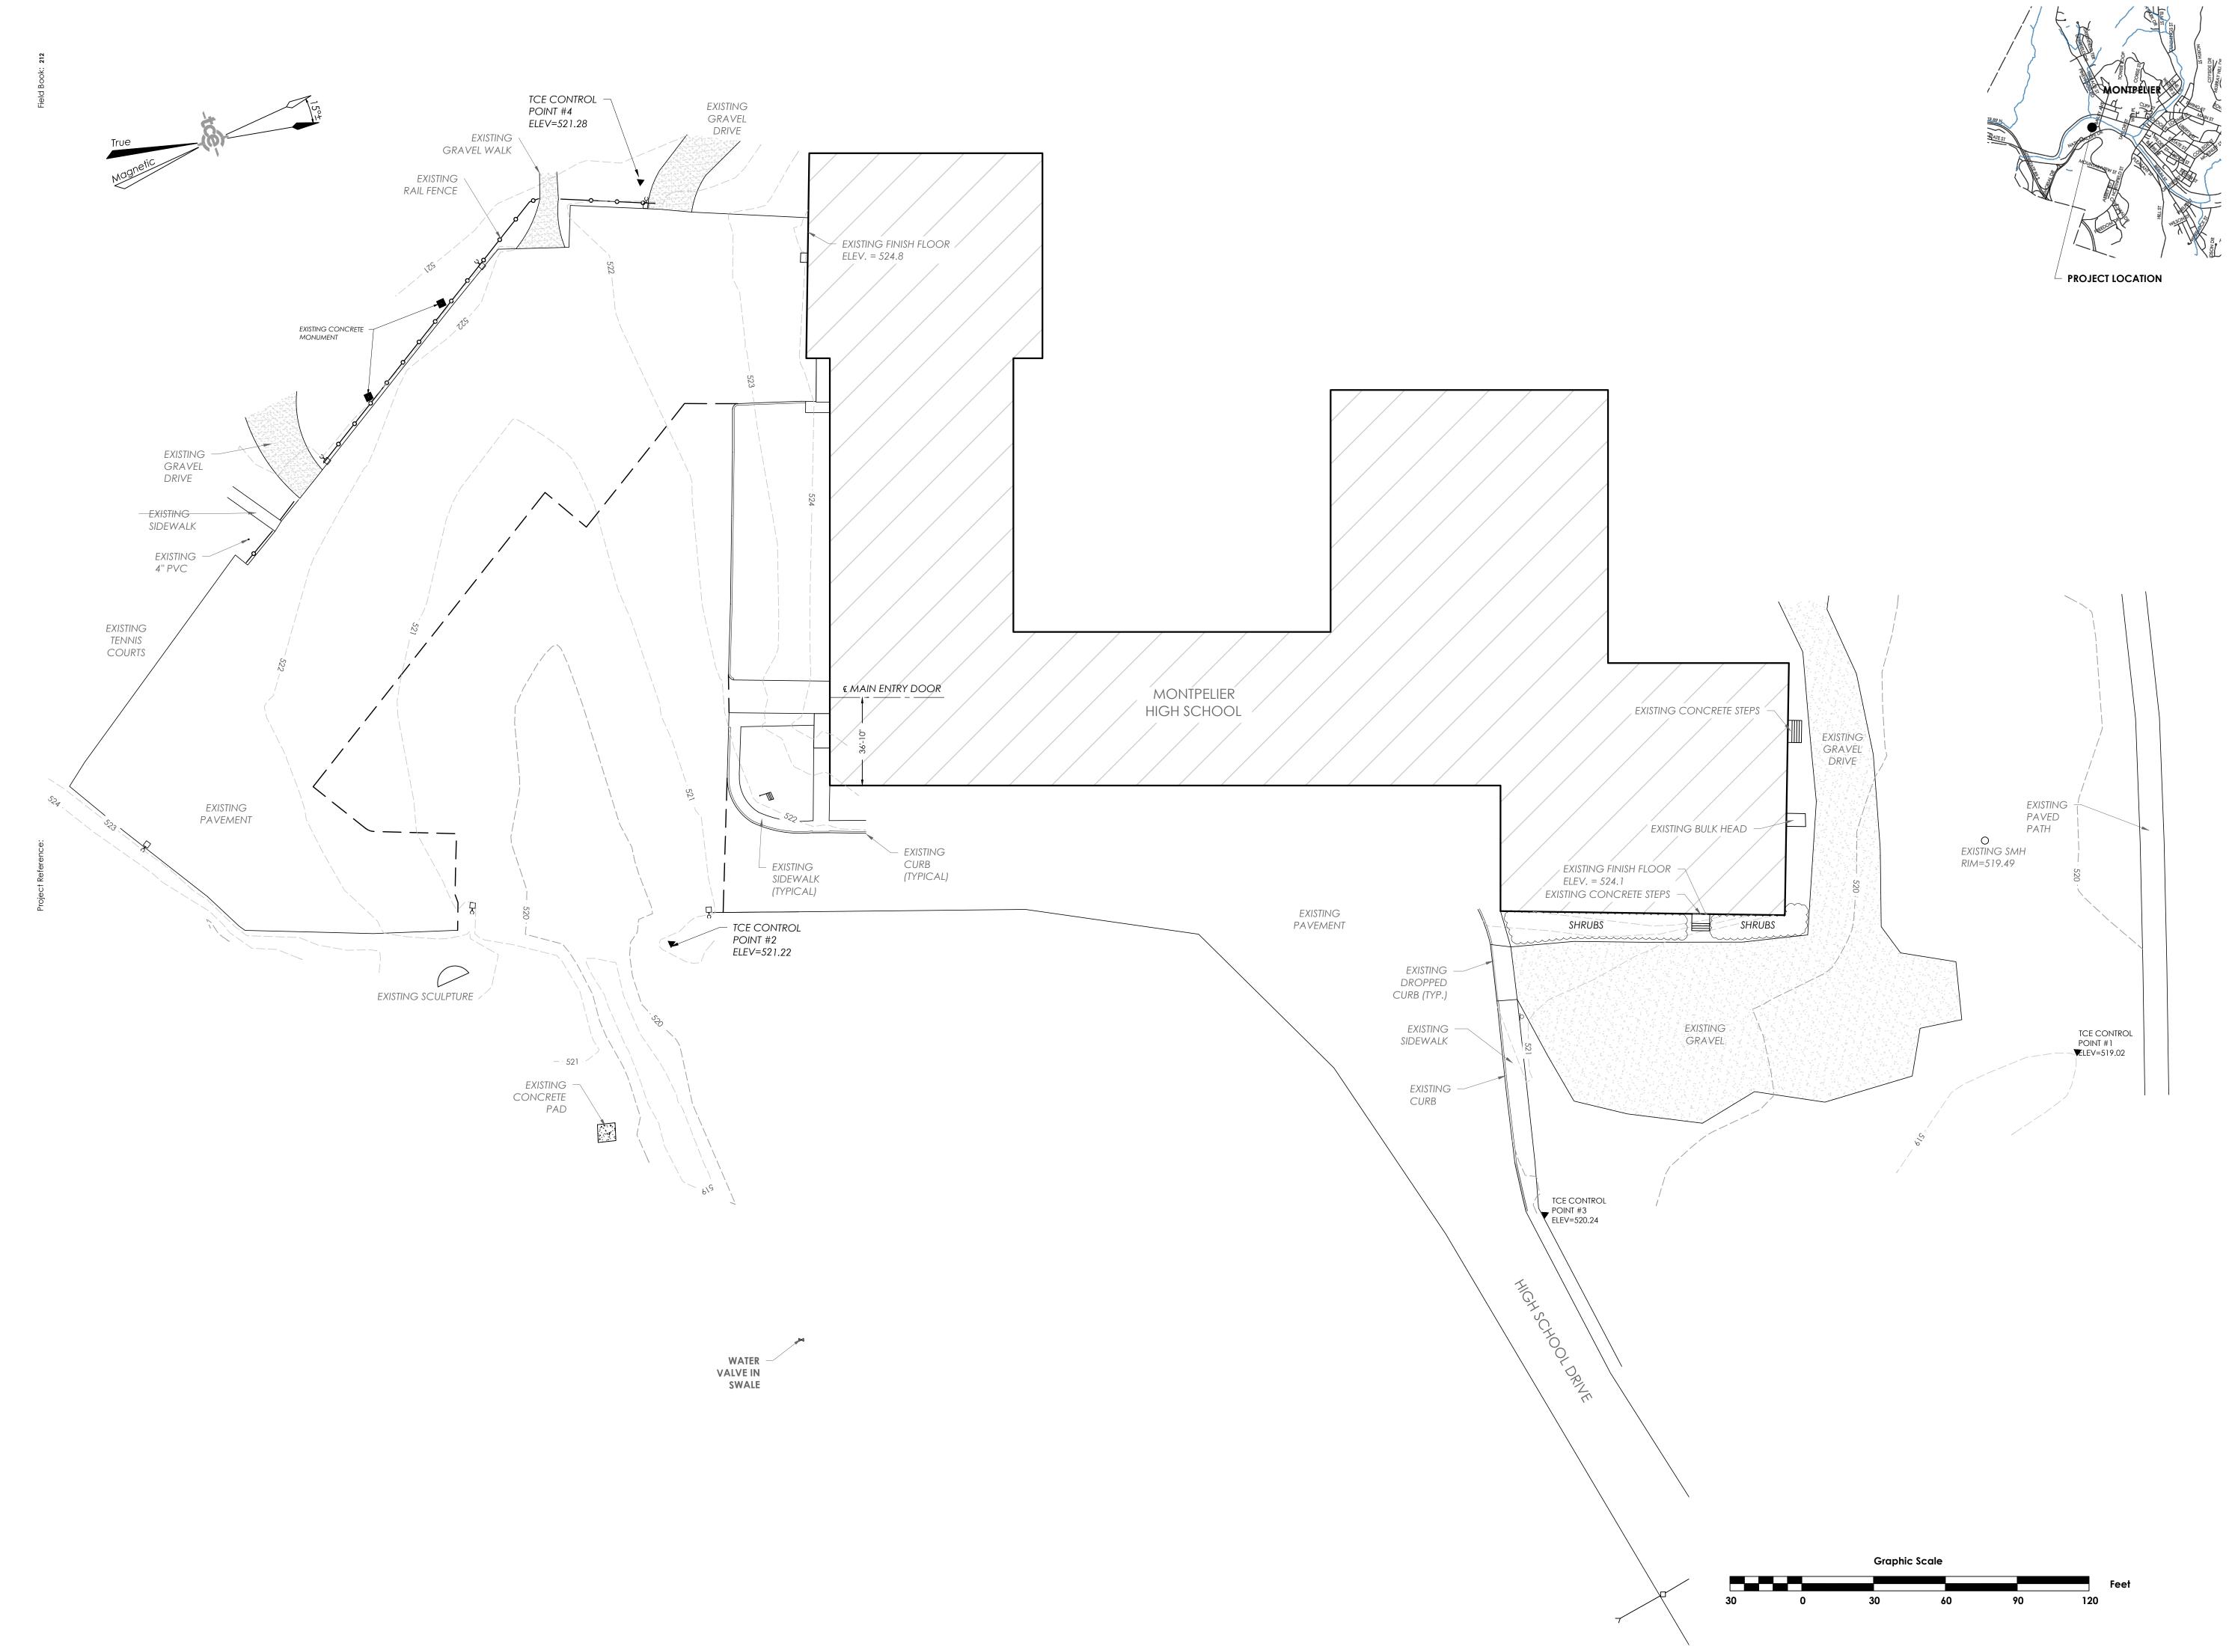


High School **Main Parking Lot** Improvement

5 High School Driv

Legend and Notes

Date:	06/12/2014
Scale:	MWOH2 2A
Project Number:	13-056
Drawn By:	RMP
Project Engineer:	SMM
Approved By:	





TRUDELL CONSULTING ENGINEERS

478 BLAIR PARK ROAD | WILLISTON, VERMONT 05495
802 879 6331 | WWW.TCEVT.COM

visions

o. Description

Addendum No. 1 06/25/14 SMM

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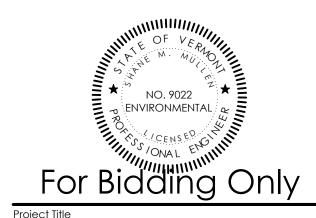
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Montpelier Public
High School
Main Parking Lot
Improvements

5 High School Drive Montpelier, VT

Sheet Title


Existing Conditions & Demolition Plan

Date:	06/12/2014
Dale.	
Scale:	1" = 30'
Project Number:	13-056
Drawn By:	RMP
Project Engineer:	SMM
Approved By:	


C1-01


3. A MINIMUM OF 12" OF SUITABLE SUBBASE (CONFORMING TO VAOT 704.5A OR 704.04) IS

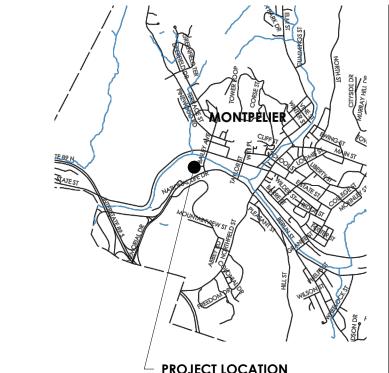REQUIRED. SUBMIT SIEVE ANALYSIS TO ENGINEER FOR CONFIRMATION.




PROJECT LOCATION

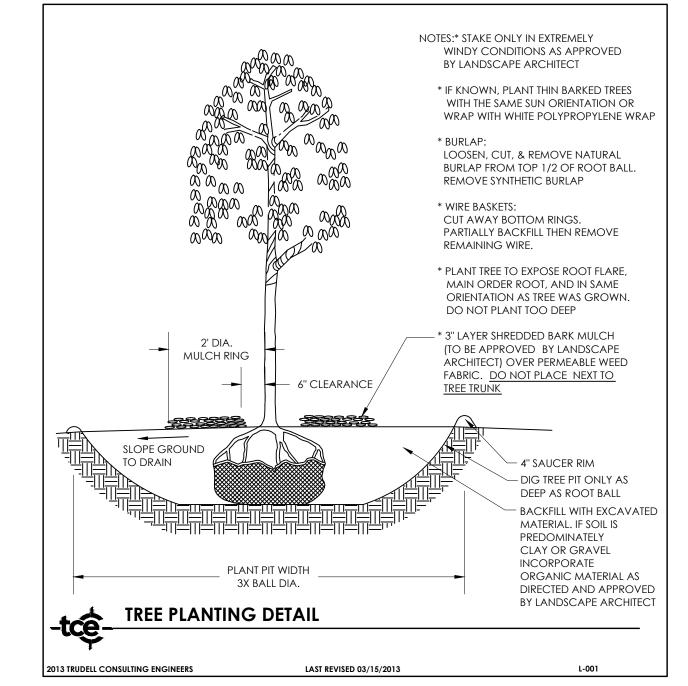

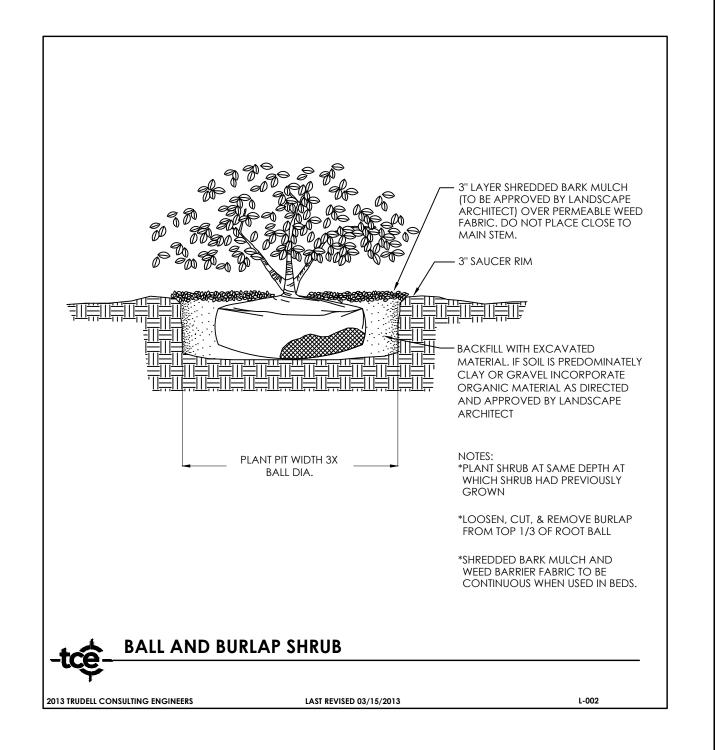

PLANT LIST

KEY	SCIENTIFIC NAME	COMMON NAME	QUAN.	SIZE	COMMENTS
AAS	Amelanchier x grandiflora	Autumn Sunset Serviceberry	2	10 gal.	Multi-stem
СО	Celtis occidentalis	Common Hackberry	2	2"-2 1/2"	B&B
GTH	Gleditsia triacanthos	Halka Honeylocust	7	2"-21/2"	B&B
JCSV	Juniperus chinensis	Sargent Green Juniper	23	2 gal.	CONT.
WFM	Weigela florida	Dwarf Pink Weigela	23	3 gal.	CONT.

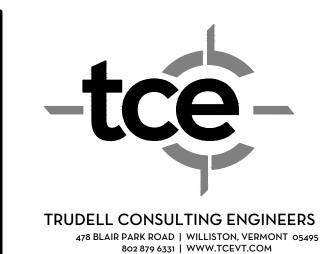

Revisions

1 Addendum No. 1 06/25/14 SMM

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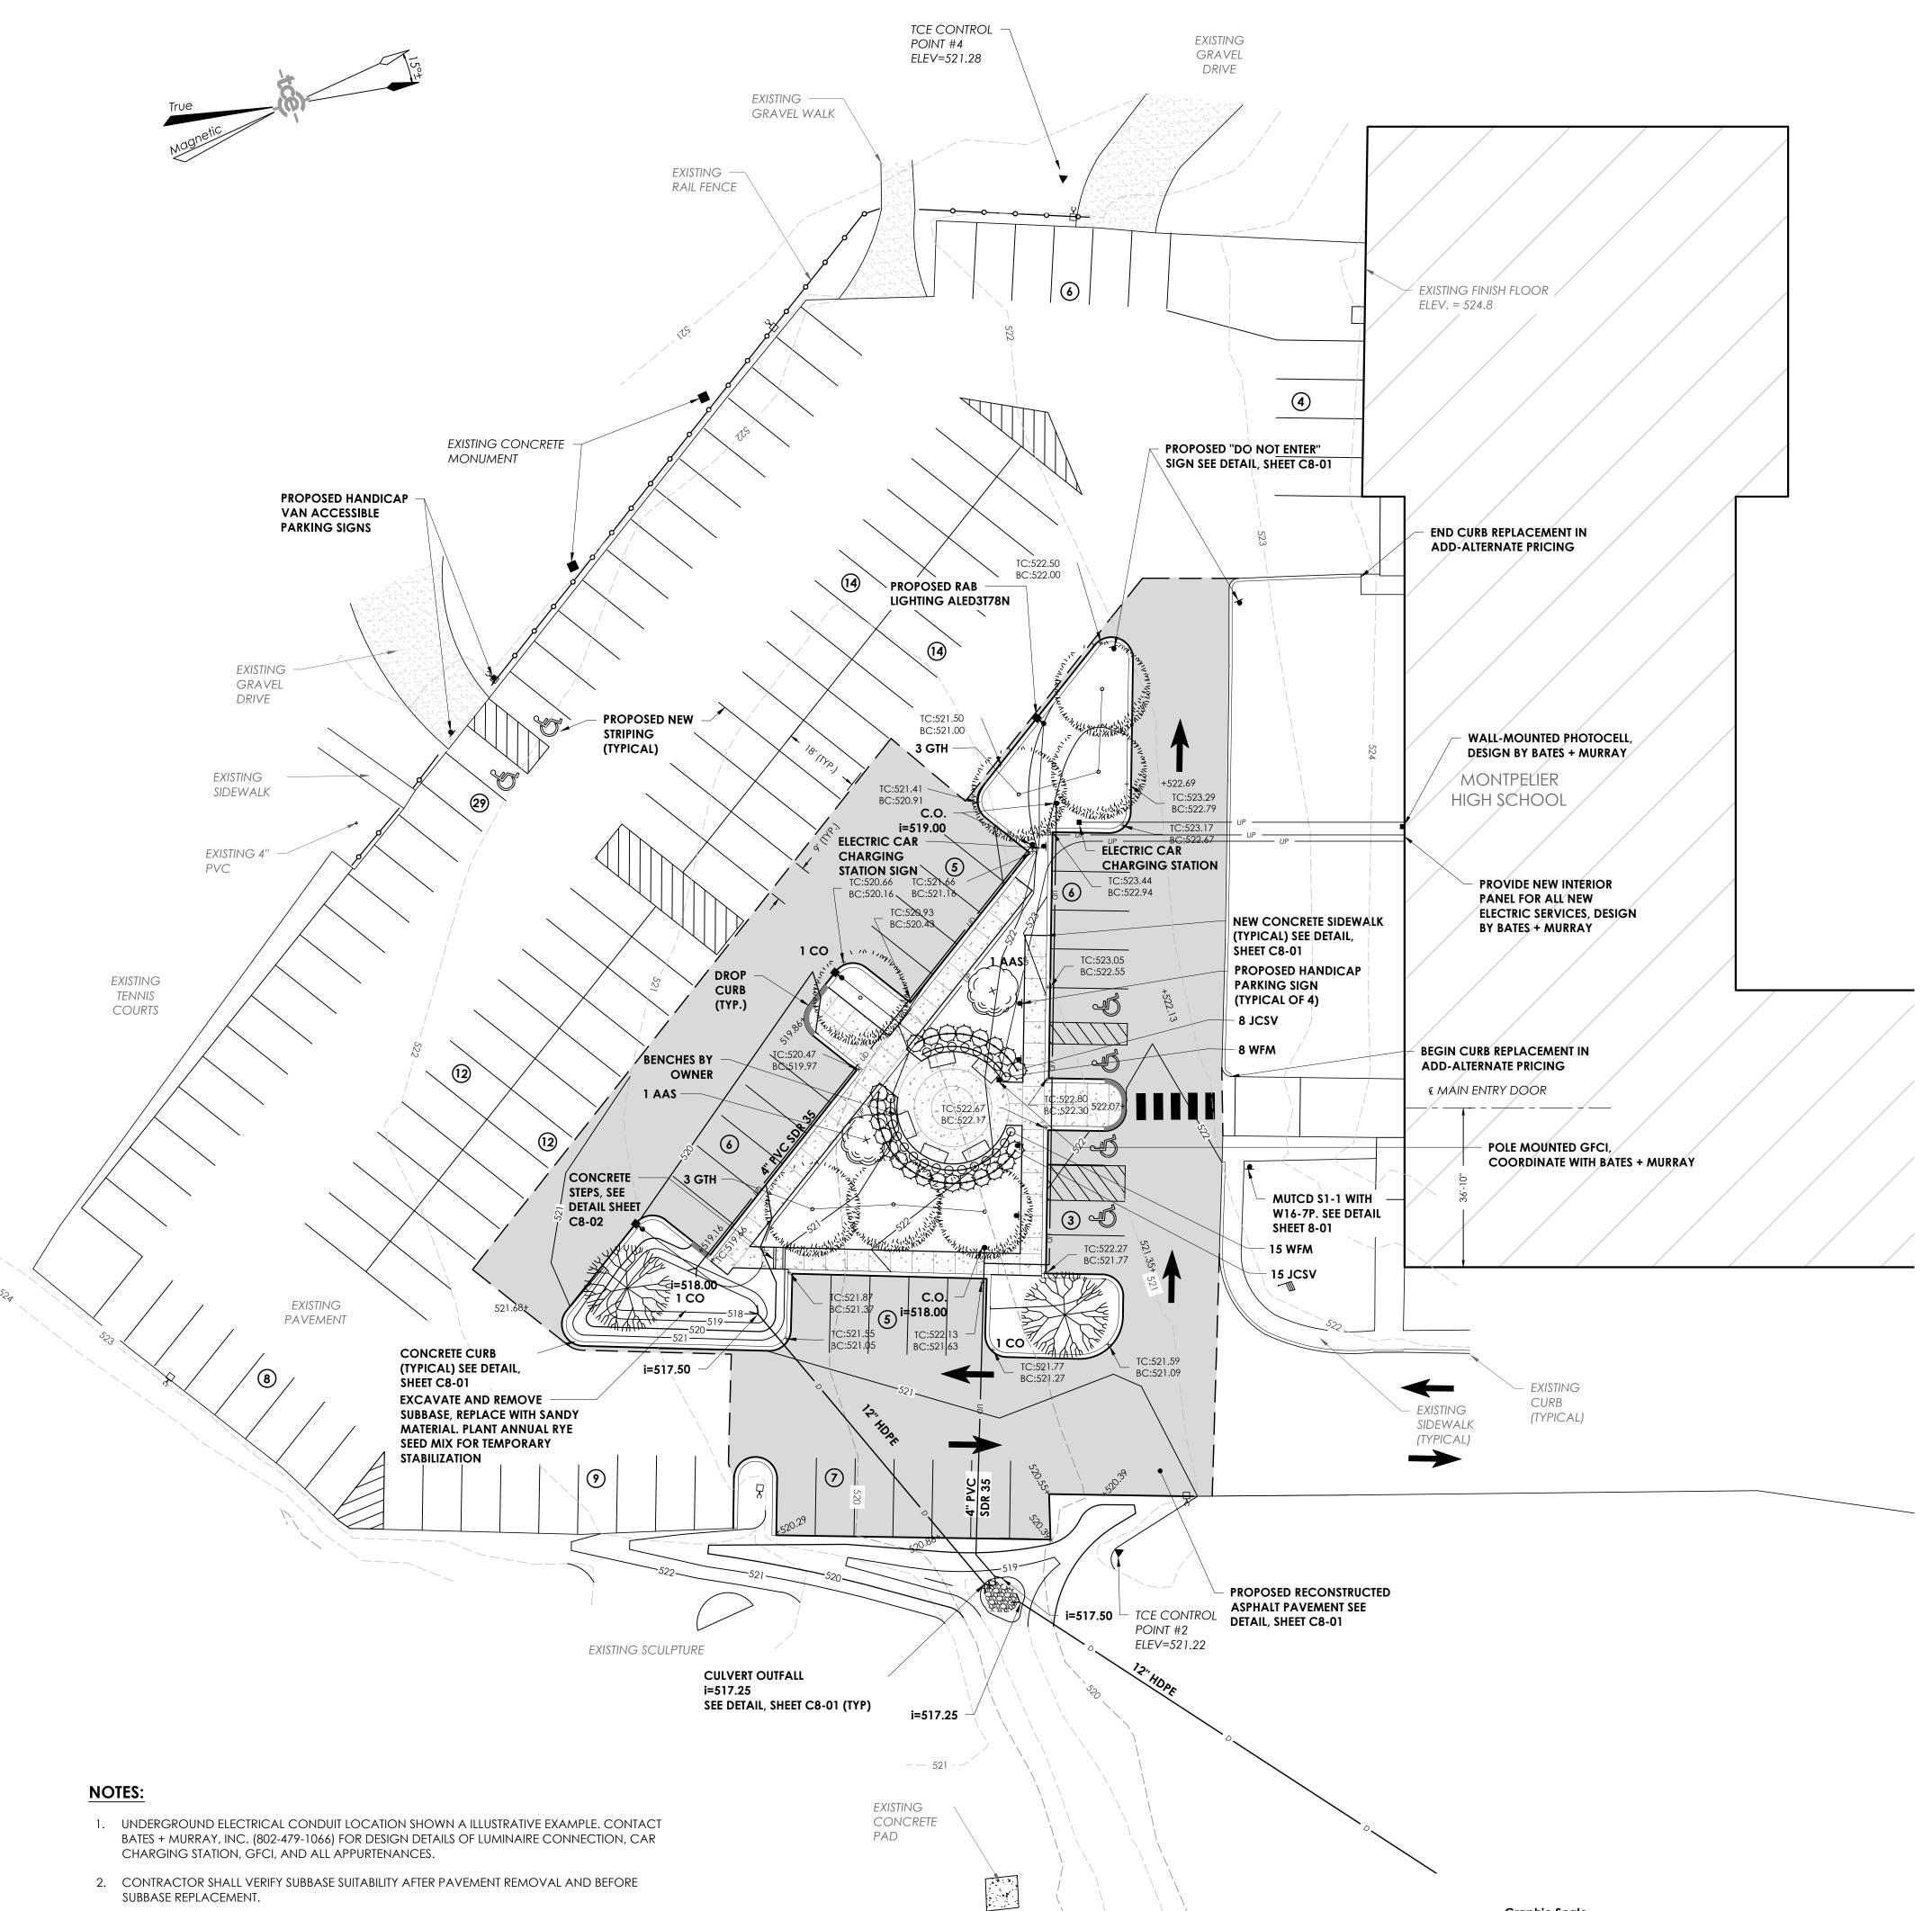
Montpelier Public High School Main Parking Lot Improvements

> 5 High School Drive Montpelier, VT

Sheet Title

Site Plan

06/12/2014		
1" = 20'		
13-056		
RMP		
SMM		



CULVERT OUTFALL i=514.50



TRUDELL CONSULTING ENGINEERS

478 BLAIR PARK ROAD | WILLISTON, VERMONT 05495

802 879 6331 | WWW.TCEVT.COM

06/25/14 SMM

Revisions

Description

No. Description

🛕 Addendum No. 1

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Montpelier Public
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Main Parking Lot
Improvements

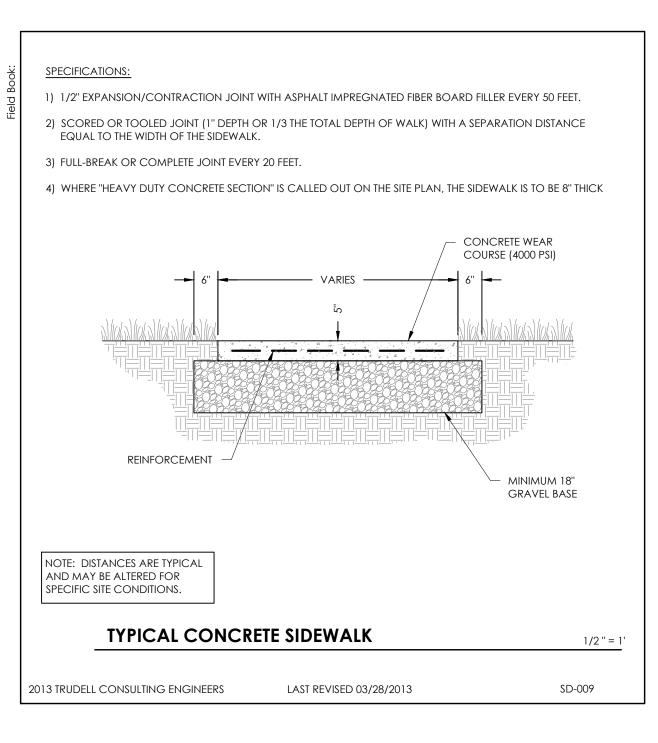
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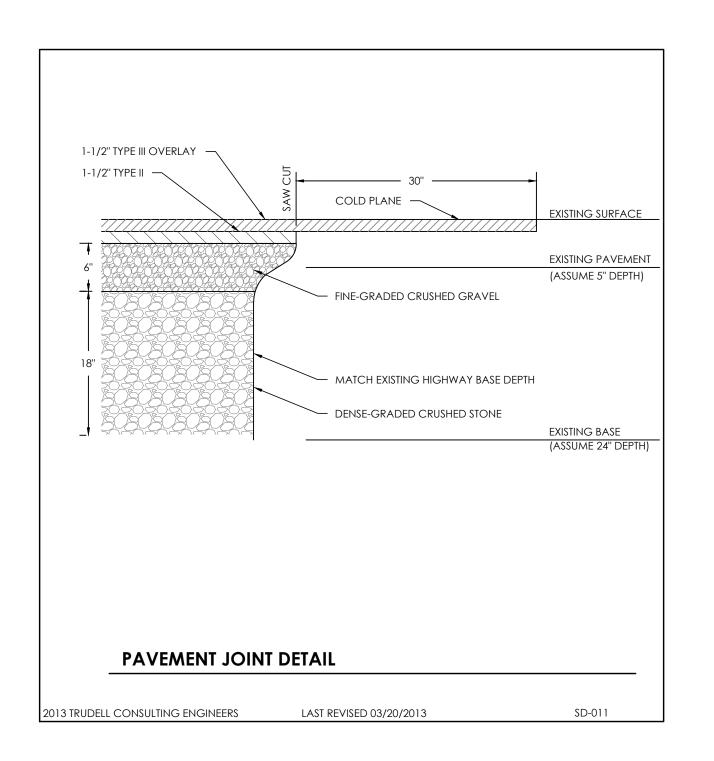
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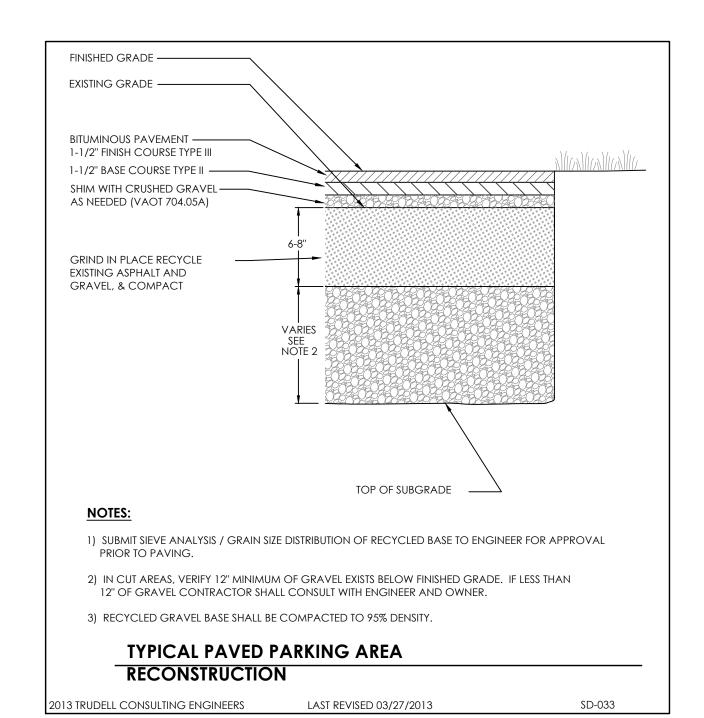
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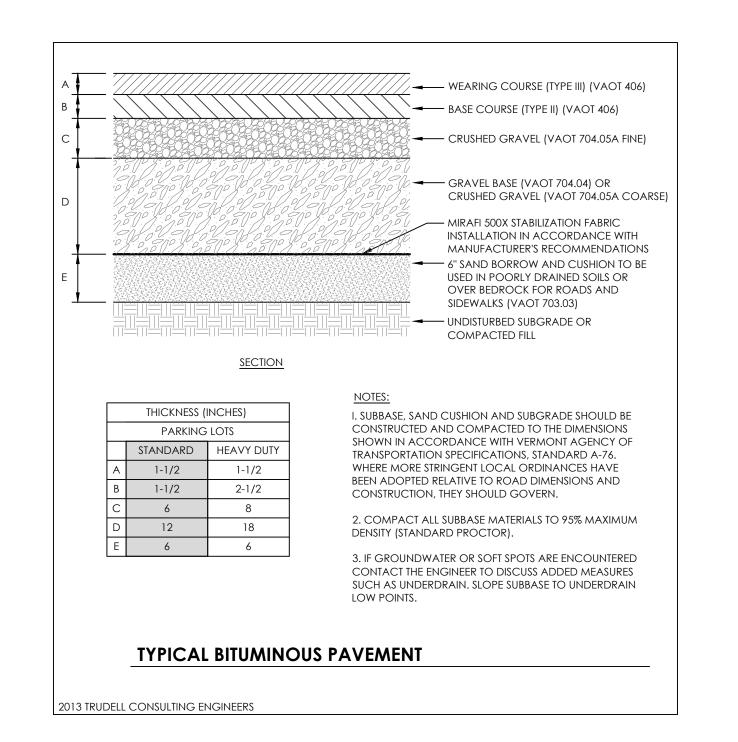
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Drawn By:	RMP
Project Engineer:	SMM
Approved By:	

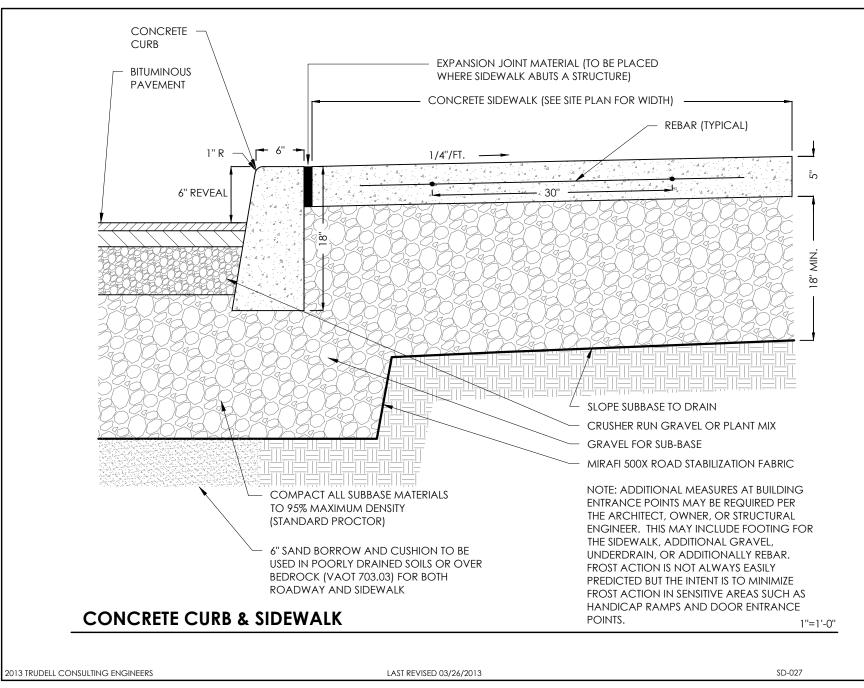
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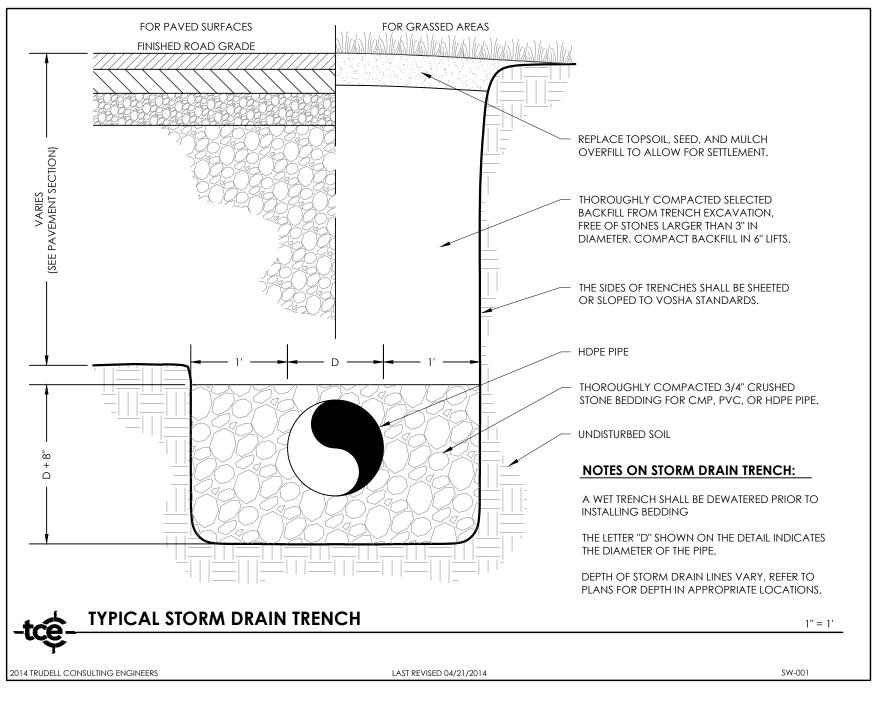


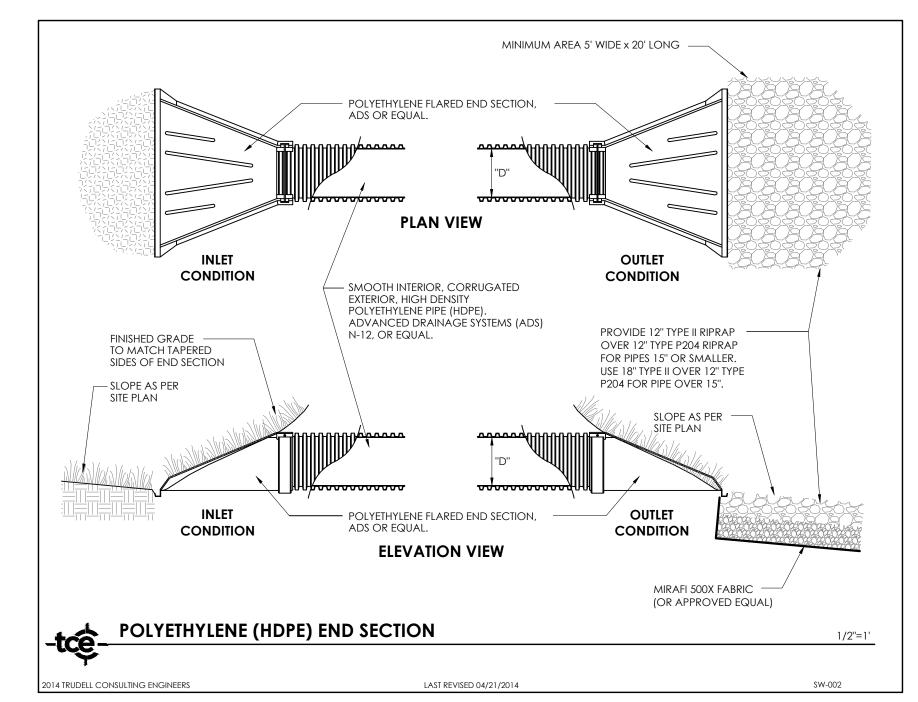


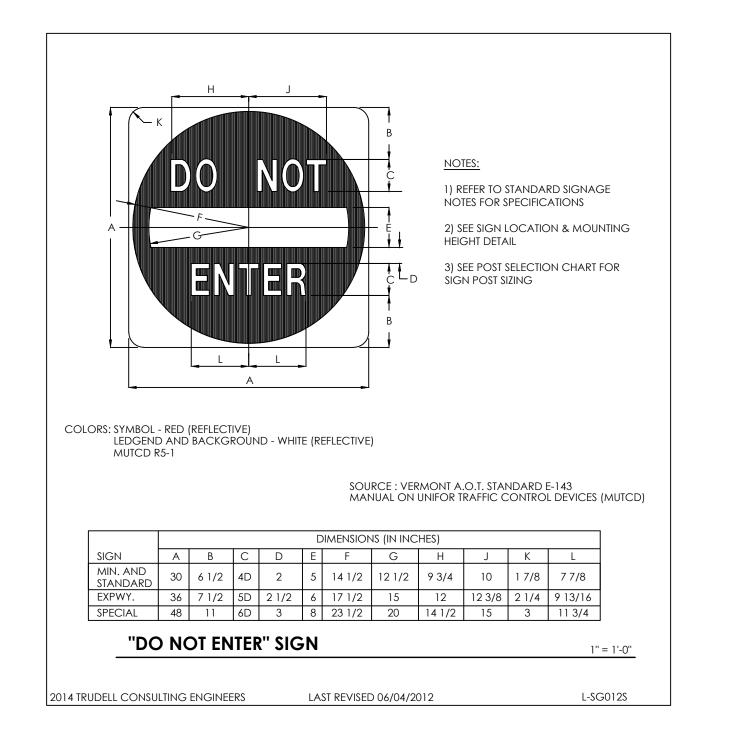


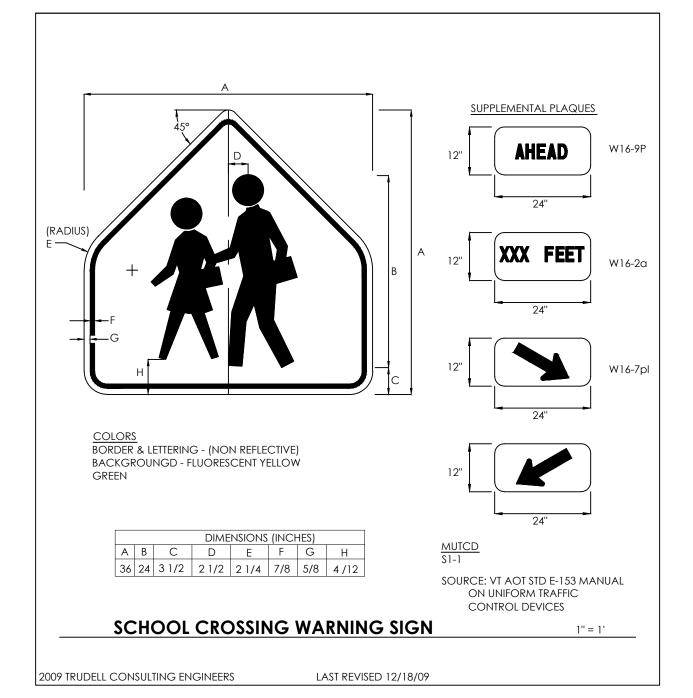


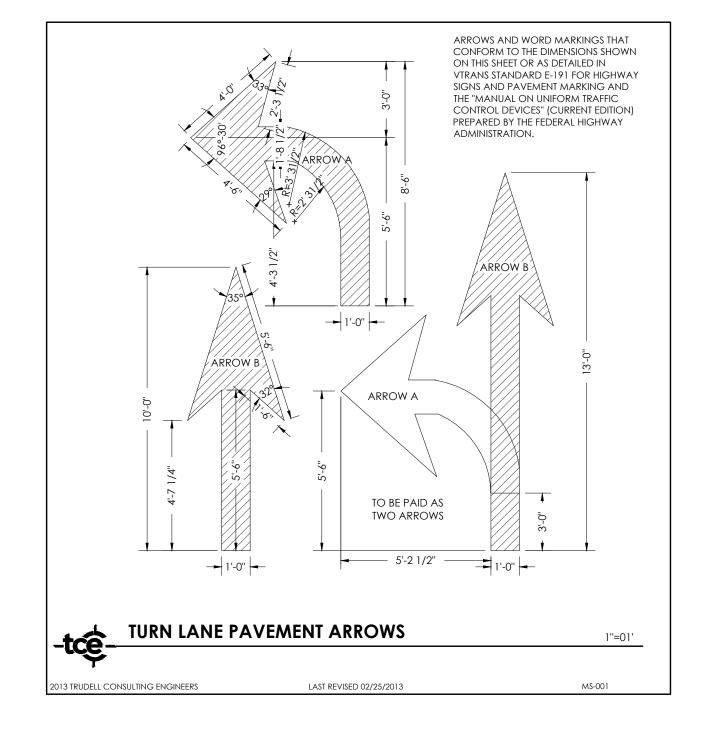


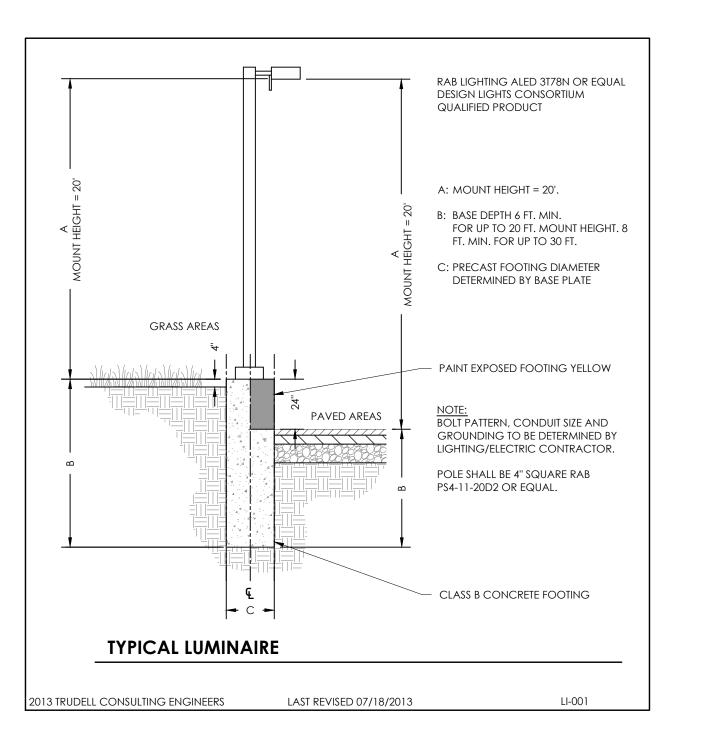














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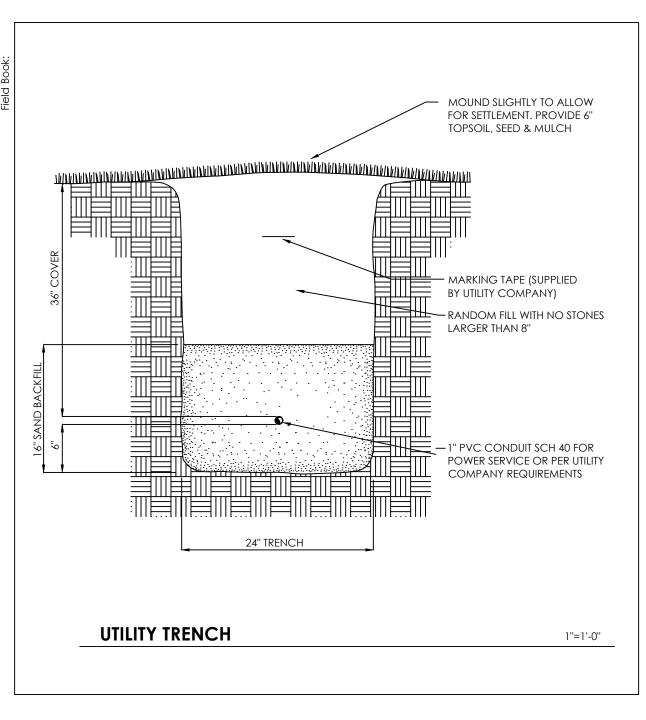
Montpelier Public High School Main Parking Lot Improvements

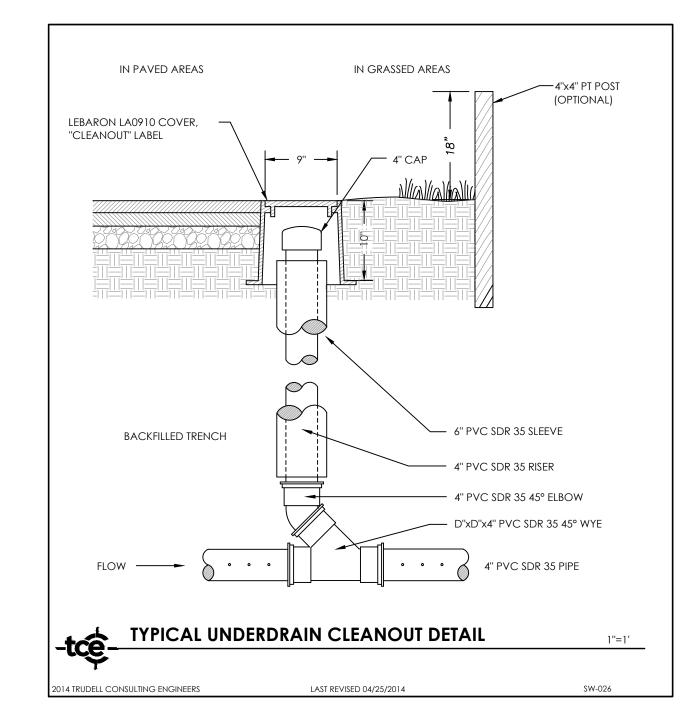
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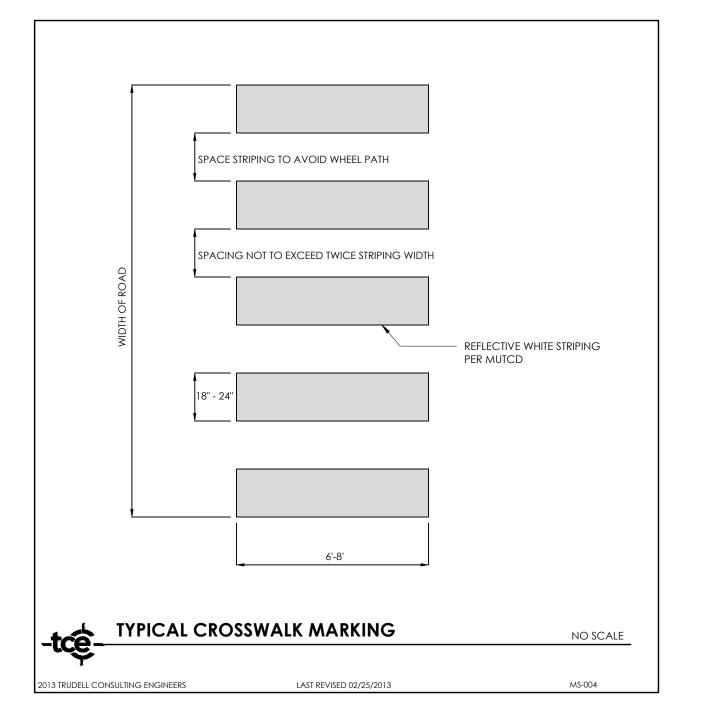
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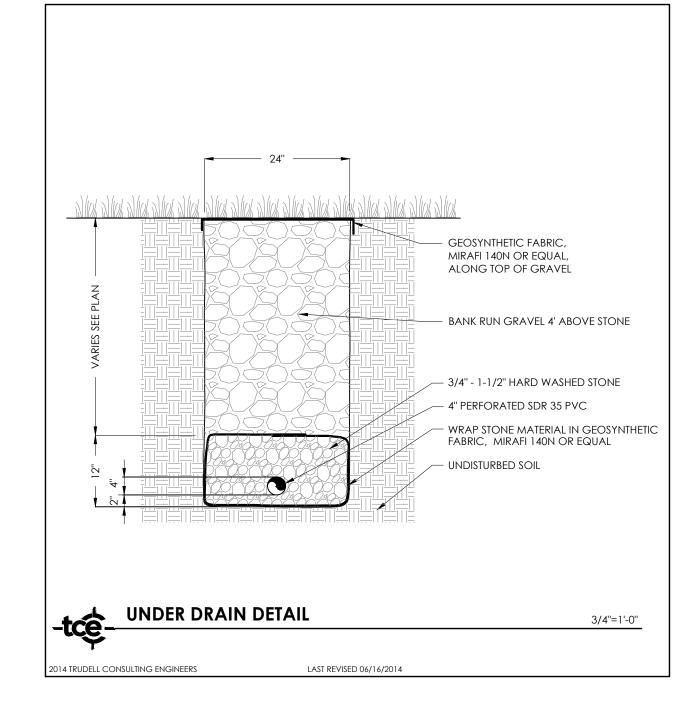
Site Details


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Scale:	AS SHOWN
Project Number:	13-056
Drawn By:	RMP
Project Engineer:	SMM
Approved By:	












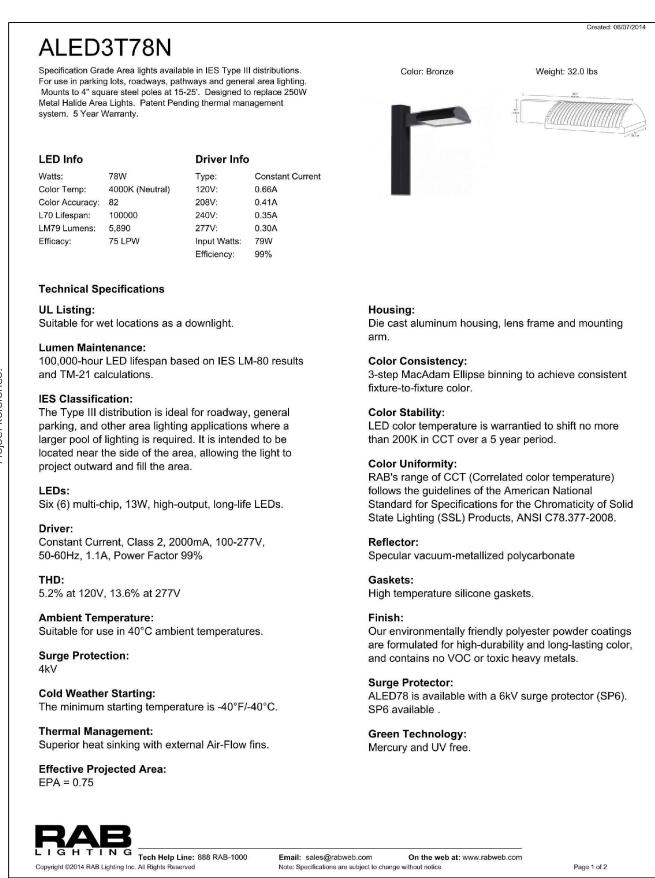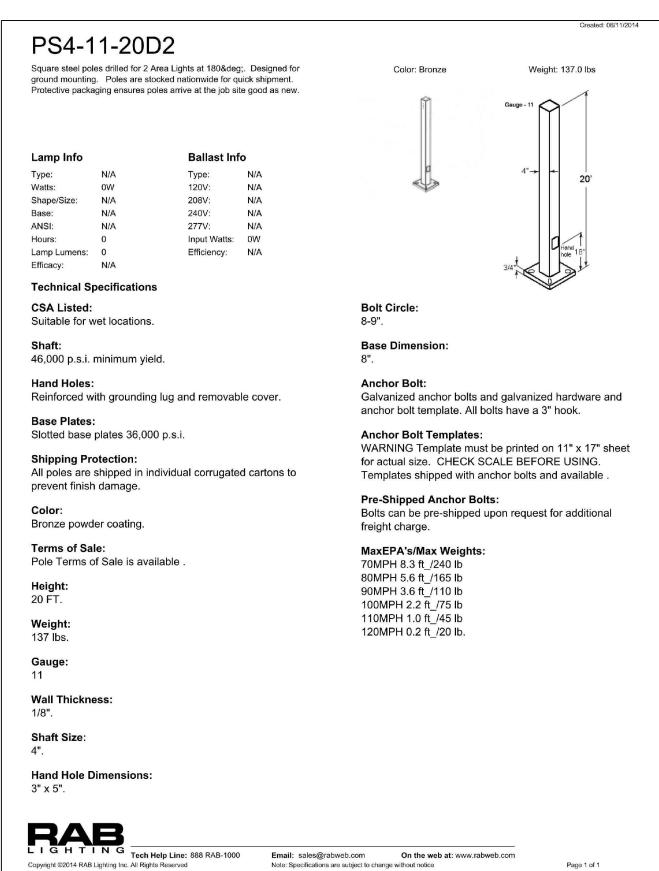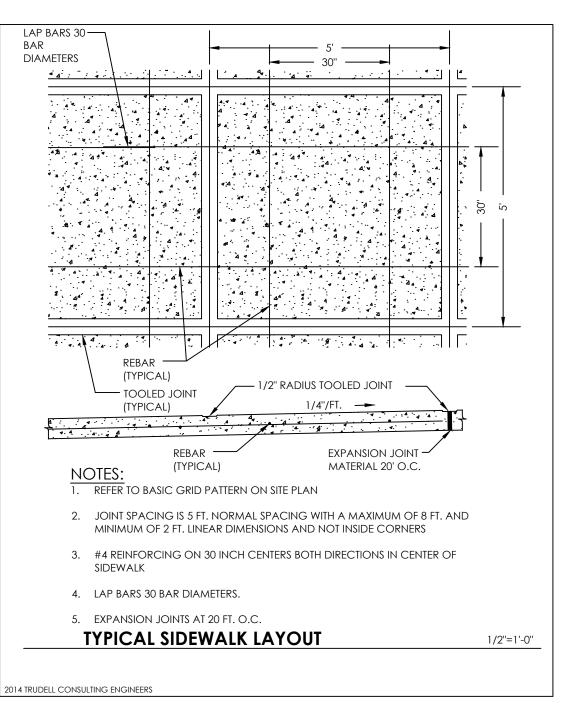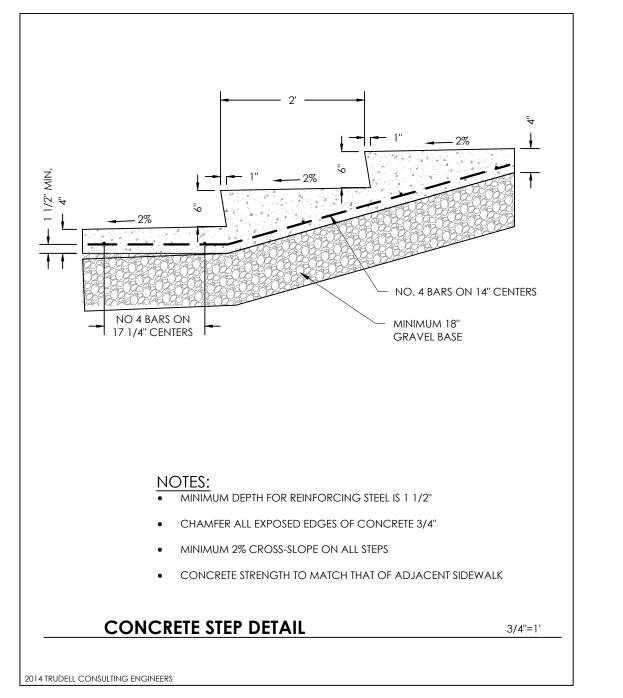



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